

426200m 426300m

?Crown Copyright and database rights 2023 OS Licence no. 100019980


THIS DRAWING IS PROTECTED BY COPYRIGHT AND MUST NOT BE COPIED OR REMOVED WITHOUT THE WRITTEN CONSENT OF ARCTIC ASSOCIATES LTD © NO DIMENSIONS ARE TO BE SCALED FROM THIS DRAWING. ALL DIMENSIONS AND SIZES TO BE CHECKED ON SITE.

Mr A Urbus & Ms Irina Raidoute Job No. 4615 **Location Plan** Scale 1:1250 @A4 Drawing No. 4615_T_00 May 2024



ARCTIC ASSOCIATES LTD 33 Queen Street Morley Leeds, LS27 8EE T: 0113 253 7040 design@arcticassociates.co.uk www.arctic-associates.co.uk

intervention conservation reger

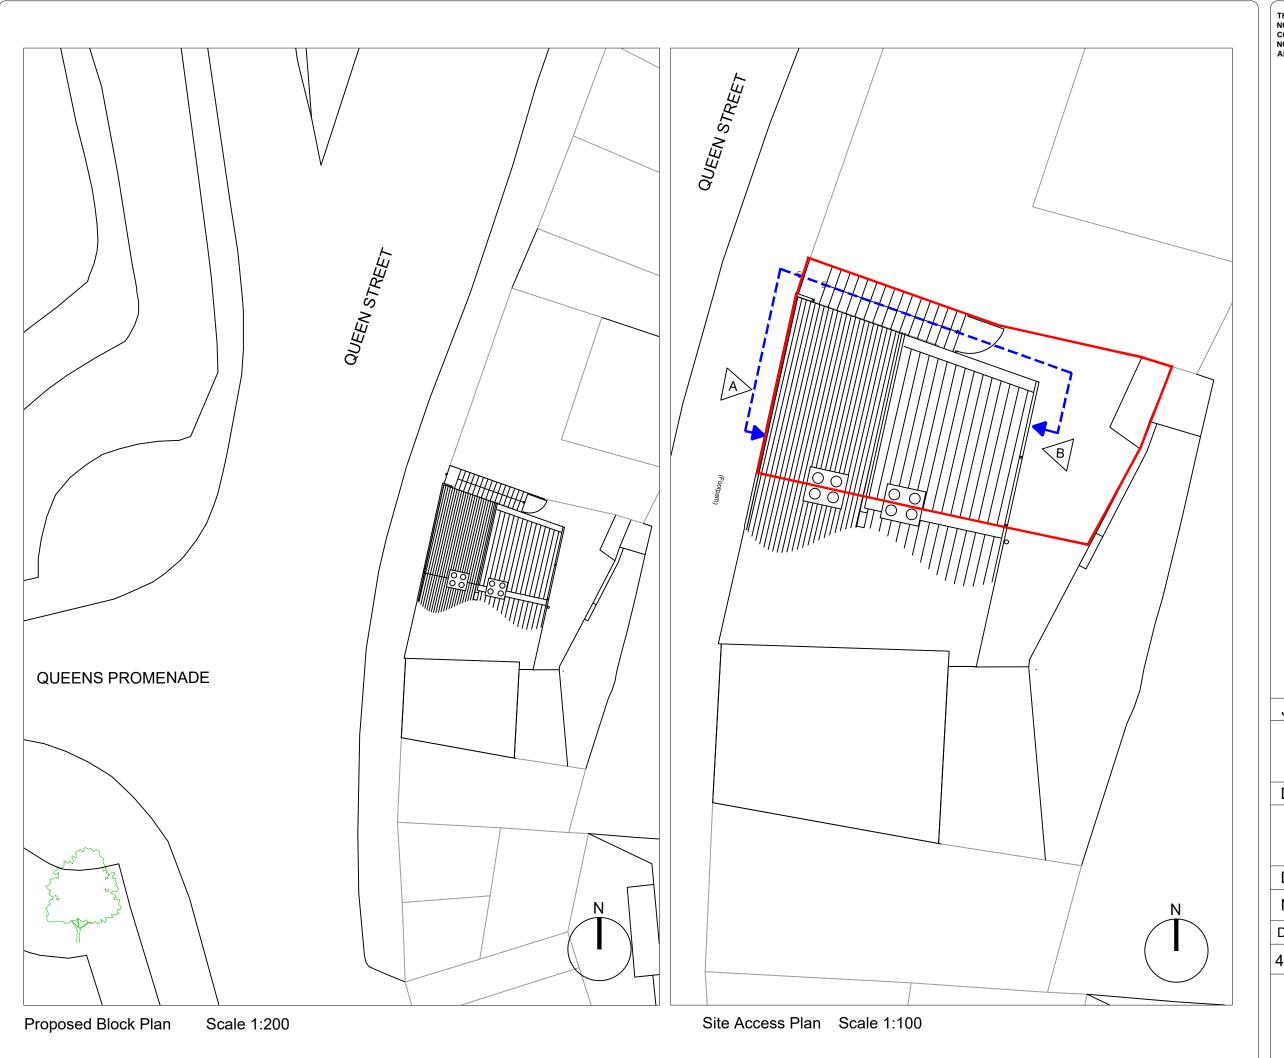

THIS DRAWING IS PROTECTED BY COPYRIGHT AND MUST NOT BE COPIED OR REMOVED WITHOUT THE WRITTEN CONSENT OF ARCTIC ASSOCIATES LTD © NO DIMENSIONS ARE TO BE SCALED FROM THIS DRAWING. ALL DIMENSIONS AND SIZES TO BE CHECKED ON SITE.

Job

31 Queen Street Morley


Drawing Title

Block and Access Plans

Date	Scale@A3	Rev
May 2024	1:100 & 200	-
Drawing No.	Drawn by	Checked
4615-T-01	CWE/ DA	RCT



ARCTIC ASSOCIATES LTD
33 Queen Street
Morley
Leeds, LS27 8EE
T: 0113 253 7040
design@ardic-associates.co.uk
www.arctic-associates.co.uk

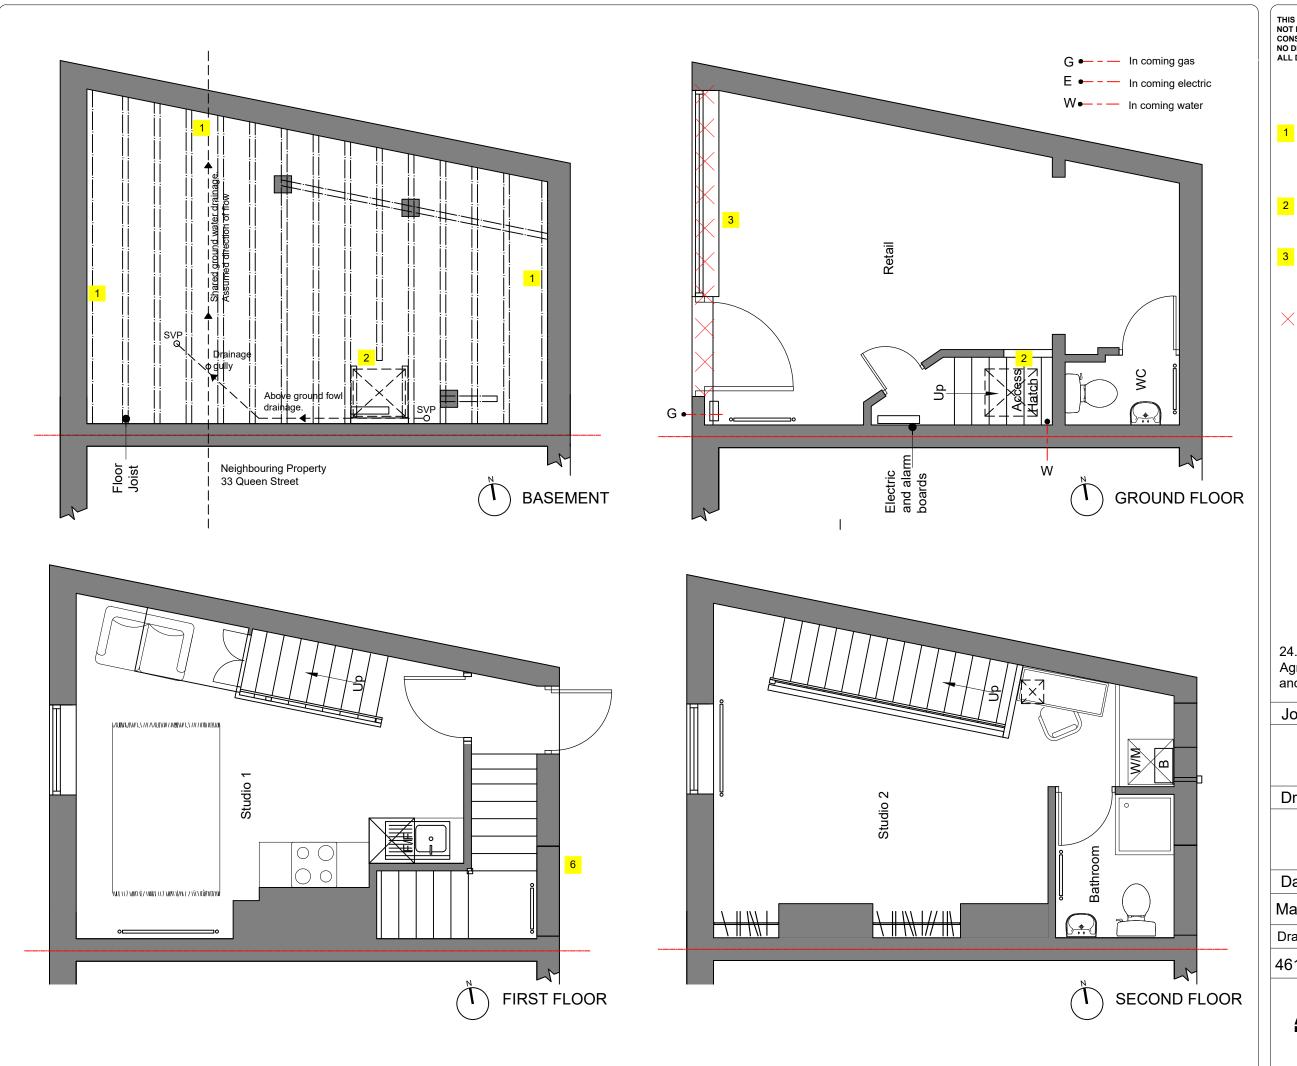

THIS DRAWING IS PROTECTED BY COPYRIGHT AND MUST NOT BE COPIED OR REMOVED WITHOUT THE WRITTEN CONSENT OF ARCTIC ASSOCIATES LTD
NO DIMENSIONS ARE TO BE SCALED FROM THIS DRAWING. ALL DIMENSIONS AND SIZES TO BE CHECKED ON SITE.

DESIGN NOTES:

- Existing load bearing masonry walls supporting timber floor joists. Walls in direct contact with ground with evidence of moisture increase. Wall to be prepared in preparation for new tanking system.
- 2 Access hatch and ladder to be removed. Defective and cut floor joist to be replaced in preparation for new floor board.
- Existing shop front window frame and door to be carefully removed and carted away. Existing mortice lock to be retained for
- X Areas of demolition and cart away

24.07.24 Rev A Agreed extent of work following tender and grant review **CWE**

Job

31 Queen Street Morley


Drawing Title

Existing Plans and Demolition

Date	Scale@A3	Rev
May 2024	1: 100	Α
Drawing No.	Drawn by	Checked
4615-T-02	DA	RCT



ARCTIC ASSOCIATES LTD 33 Queen Street Morley Leeds, LS27 8EE T: 0113 253 7040

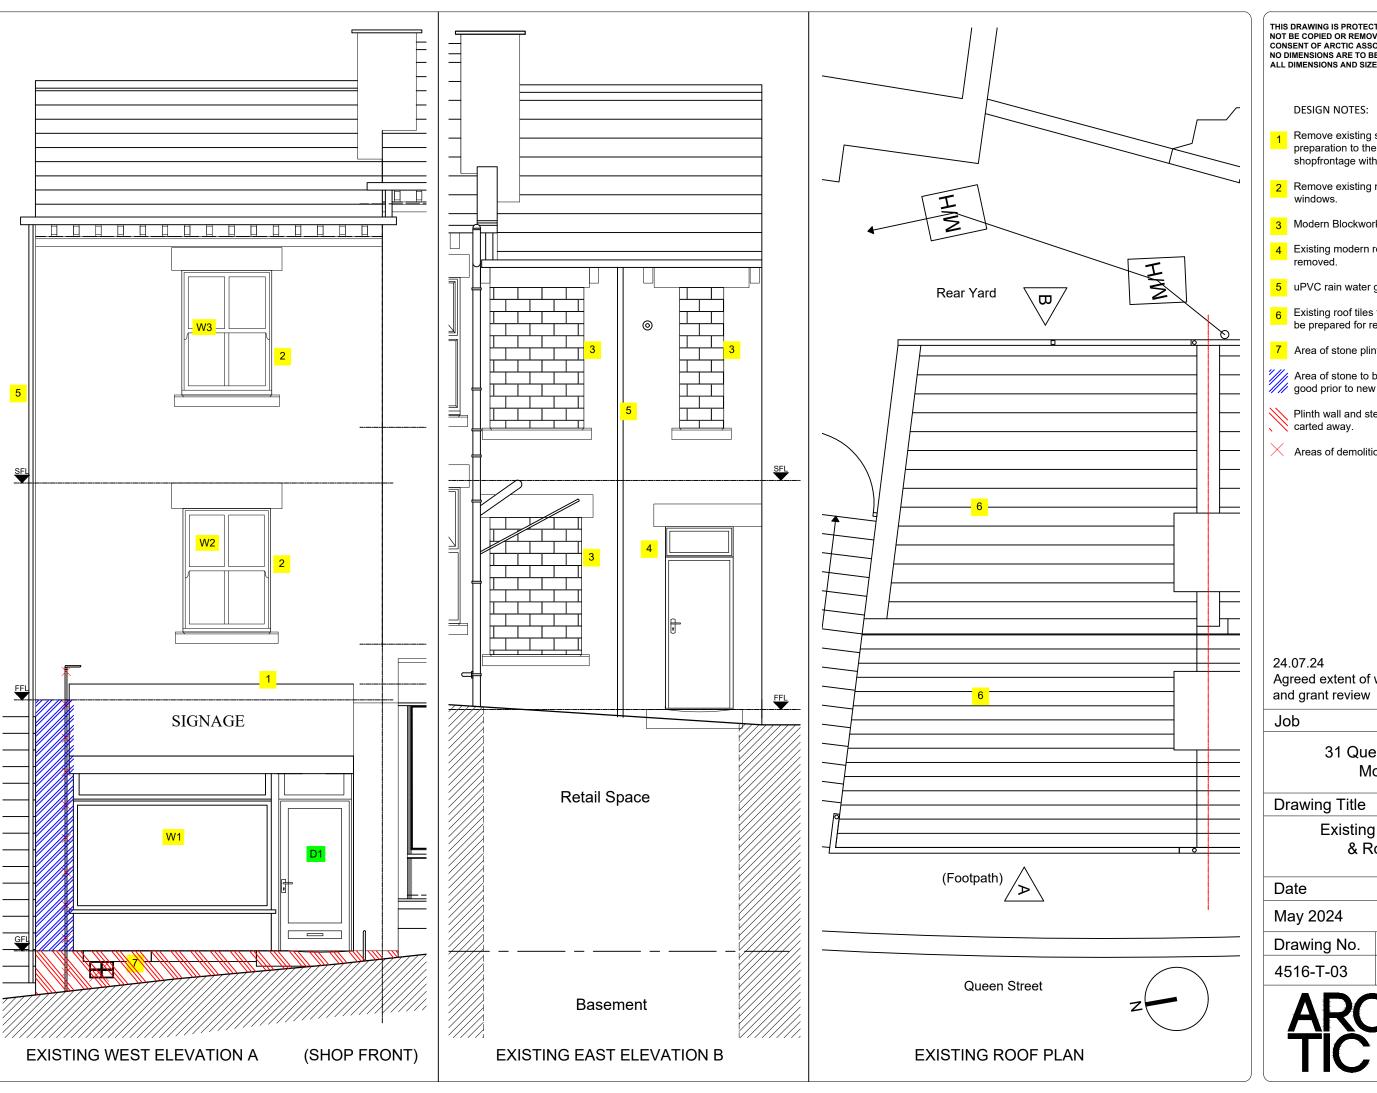

THIS DRAWING IS PROTECTED BY COPYRIGHT AND MUST NOT BE COPIED OR REMOVED WITHOUT THE WRITTEN CONSENT OF ARCTIC ASSOCIATES LTD \circledcirc NO DIMENSIONS ARE TO BE SCALED FROM THIS DRAWING.
ALL DIMENSIONS AND SIZES TO BE CHECKED ON SITE.

- Remove existing shopfront and support in preparation to the install new timber framed shopfrontage with window display.
- Remove existing modern uPVC casement
- Modern Blockwork to be removed.
- 4 Existing modern rear timber door to be
- 5 uPVC rain water good to be removed.
- 6 Existing roof tiles to be removed and roof to be prepared for re-roofing.
- 7 Area of stone plinth wall to be replaced.
- Area of stone to be investigated and made good prior to new shopfront installation.
- Plinth wall and step step to be removed and
- Areas of demolition and cart away.

Rev A Agreed extent of work following tender **CWE**

> 31 Queen Street Morley

Existing Elevations & Roof Plan

Date		Scale	@A3
May 2024		1: 50	
Drawing No.	Dra	wn by	Rev
4516-T-03	CWE	/DDA	Α



33 Queen Street Morley Leeds, LS27 8EE T: 0113 253 7040



THIS DRAWING IS PROTECTED BY COPYRIGHT AND MUST NOT BE COPIED OR REMOVED WITHOUT THE WRITTEN CONSENT OF ARCTIC ASSOCIATES LTD © NO DIMENSIONS ARE TO BE SCALED FROM THIS DRAWING. ALL DIMENSIONS AND SIZES TO BE CHECKED ON SITE.

Emergency bulkhead lighting

Distribution Board (location TBC on site).

Fire Panel (location TBC on site).

Vent Axia Quadra TP Extract Fan or similar.

LED Batten Waterproof fitting

One way switch

D++ Fused spur

Description
Double power socket

Rev A Agreed extent of work following tender and grant review

31 Queen Street Morley


Drawing title

Proposed plans and North Elevation

Date		Scale@A2	Rev
May 202	4	1: 50	Α
Drawing	No.	Drawn by	Checked
4615-T-0	04	DDA	RCT



ARCTIC ASSOCIATES LTD Leeds, LS27 8EE T: 0113 253 7040 design@arctic-associates.co.uk www.arctic-associates.co.uk

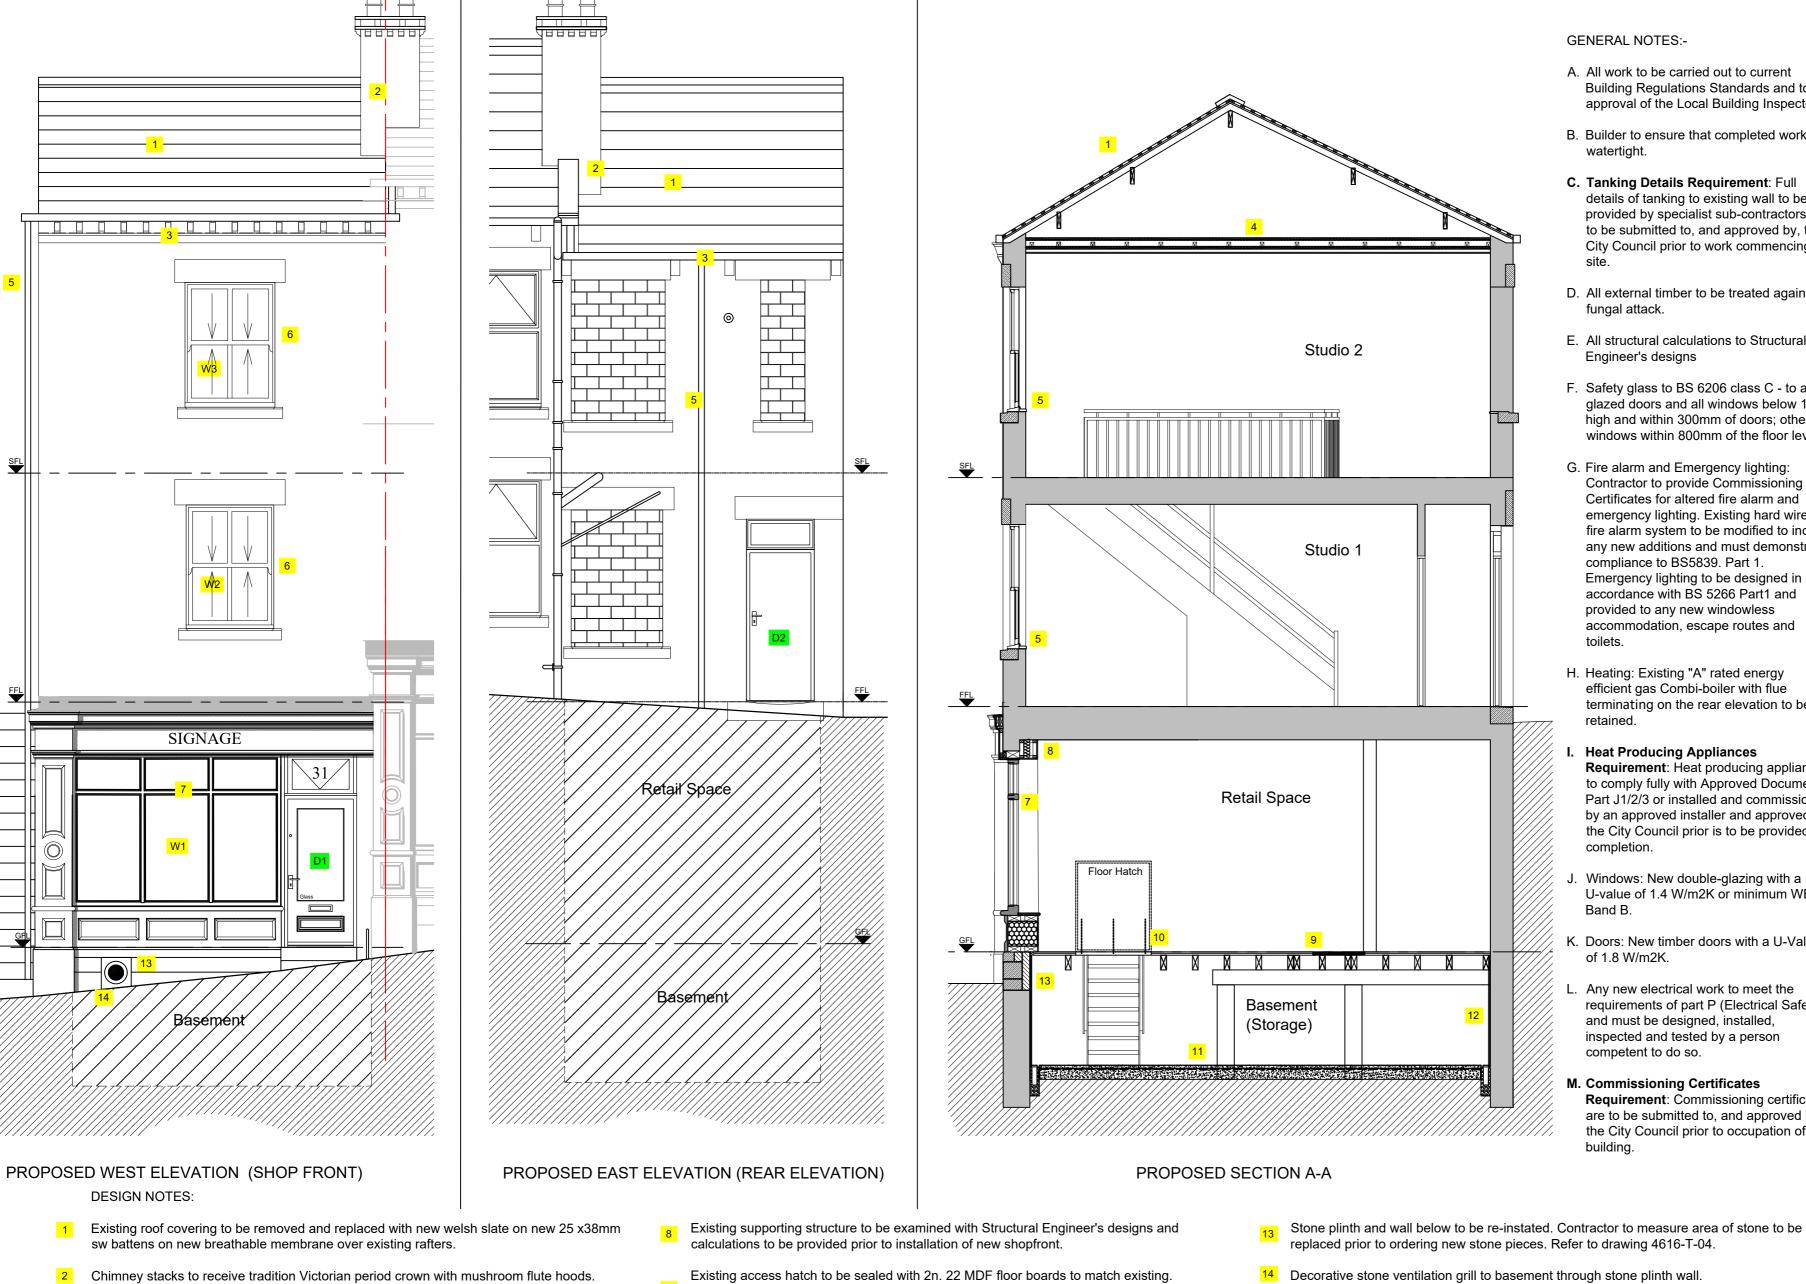

Modern uPVC gutters to be replace with lead lined timber gutters.

light vent above. Glazing to be LandVac Heritage glazing 8.3mm.

a maximum U-Value of 0.16W/m.sq.K.

style double glazed vertical sash window.

Existing ceiling to be retained with the addition of a minimum of 150mm fibreglass between

joists and a further 150mm fibreglass laid across to give 300mm total thickness to achieve

Existing modern uPVC casement windows to be replaced with new timber framed Victorian

New European Hardwood timber framed shopfrontage window display and door with top

Modern uPVC rainwater pipes to be replace with new cast iron rain water pipes.

GENERAL NOTES:-

- A. All work to be carried out to current Building Regulations Standards and to approval of the Local Building Inspector.
- B. Builder to ensure that completed work is watertight.
- C. Tanking Details Requirement: Full details of tanking to existing wall to be provided by specialist sub-contractors and to be submitted to, and approved by, the City Council prior to work commencing on
- D. All external timber to be treated against fungal attack.
- E. All structural calculations to Structural Engineer's designs
- F. Safety glass to BS 6206 class C to all glazed doors and all windows below 1500 high and within 300mm of doors; other windows within 800mm of the floor level
- G. Fire alarm and Emergency lighting: Contractor to provide Commissioning Certificates for altered fire alarm and emergency lighting. Existing hard wired fire alarm system to be modified to include any new additions and must demonstrate compliance to BS5839. Part 1. Emergency lighting to be designed in accordance with BS 5266 Part1 and provided to any new windowless accommodation, escape routes and toilets.
- H. Heating: Existing "A" rated energy efficient gas Combi-boiler with flue terminating on the rear elevation to be retained.
- **Heat Producing Appliances Requirement**: Heat producing appliances to comply fully with Approved Document Part J1/2/3 or installed and commissioned by an approved installer and approved by, the City Council prior is to be provided on completion.
- J. Windows: New double-glazing with a U-value of 1.4 W/m2K or minimum WER Band B.
- K. Doors: New timber doors with a U-Value of 1.8 W/m2K.
- L. Any new electrical work to meet the requirements of part P (Electrical Safety) and must be designed, installed, inspected and tested by a person competent to do so.
- M. Commissioning Certificates **Requirement**: Commissioning certificates are to be submitted to, and approved by, the City Council prior to occupation of the building.

24.07.24 Rev A Agreed extent of work following tender and grant review

THIS DRAWING IS PROTECTED BY COPYRIGHT AND MUST NOT BE COPIED OR REMOVED WITHOUT THE WRITTEN

NO DIMENSIONS ARE TO BE SCALED FROM THIS DRAWING.

Refer to the Specification of Works document for the description of

re-pointing works to all elevations.

ALL DIMENSIONS AND SIZES TO BE CHECKED ON SITE.

CONSENT OF ARCTIC ASSOCIATES LTD ©

Job

31 Queen Street Morley

Drawing title

Proposed East & West Elevations and Section A-A

Scale@A2 Rev Date May 2024 1: 50 Drawing No. Drawn by Checked 4615-T-05 DDA RCT



ARCTIC ASSOCIATES LTD design@arctic-associates.co.uk www.arctic-associates.co.uk

Replace floor joist with new 75 x 195 sw joist to match existing hung on party wall and

and retrieval areas by Hidex Hidden Access Panel. Floor joist to be cut and trimmed to suit.


Basement tanking system to be of Type C; grade 3 standard in accordance with

Perimeter walls tanked with Platon P8 membrane, covered with PB2 mesh and finished with dot and dabbed 12.5mm plasterboard. All joint to be taped with Triton Platon sealing

gable wall with new wall hungers.

New hatch and ladder to be formed in existing floor for easy access to basement storage Allow for Structural engineer's designs and calculations.

rope (or similar approved) prior to skim coat plastering.

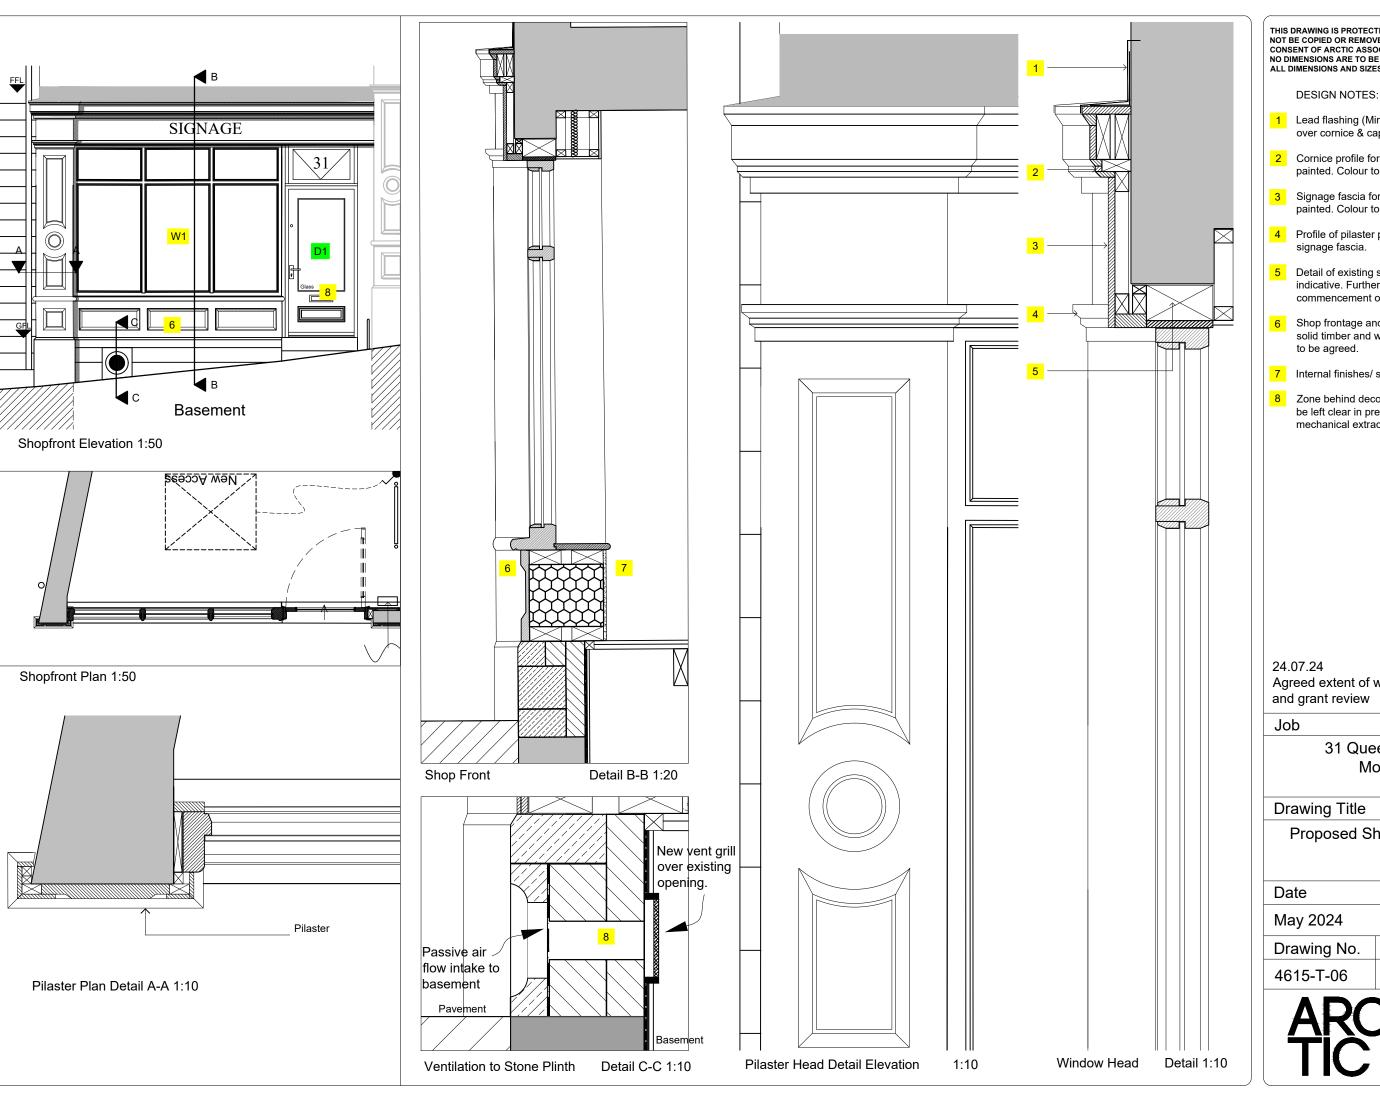

THIS DRAWING IS PROTECTED BY COPYRIGHT AND MUST NOT BE COPIED OR REMOVED WITHOUT THE WRITTEN CONSENT OF ARCTIC ASSOCIATES LTD © NO DIMENSIONS ARE TO BE SCALED FROM THIS DRAWING. ALL DIMENSIONS AND SIZES TO BE CHECKED ON SITE.

- 1 Lead flashing (Minimum code 4) dressed over cornice & capital detail of pilaster.
- 2 Cornice profile formed in timber and painted. Colour to be agreed.
- Signage fascia formed in 18mm wbp ply painted. Colour to be agreed.
- 4 Profile of pilaster projects in front of signage fascia.
- 5 Detail of existing structural opening is indicative. Further investigation prior to commencement of work.
- Shop frontage and stall risers formed in solid timber and wbp ply painted. Colour
- 7 Internal finishes/ shop fitout TBC.
- Zone behind decorative stone piece to be left clear in preparation for future mechanical extract installation.

Rev A Agreed extent of work following tender **CWE**

> 31 Queen Street Morley


Proposed Shopfront Details


May 2024		Variou	S
Drawing No.	Dra	wn by	Rev
4615-T-06	CW	E/DDA	Α



33 Queen Street Morley Leeds, LS27 8EE T: 0113 253 7040

Scale@A3

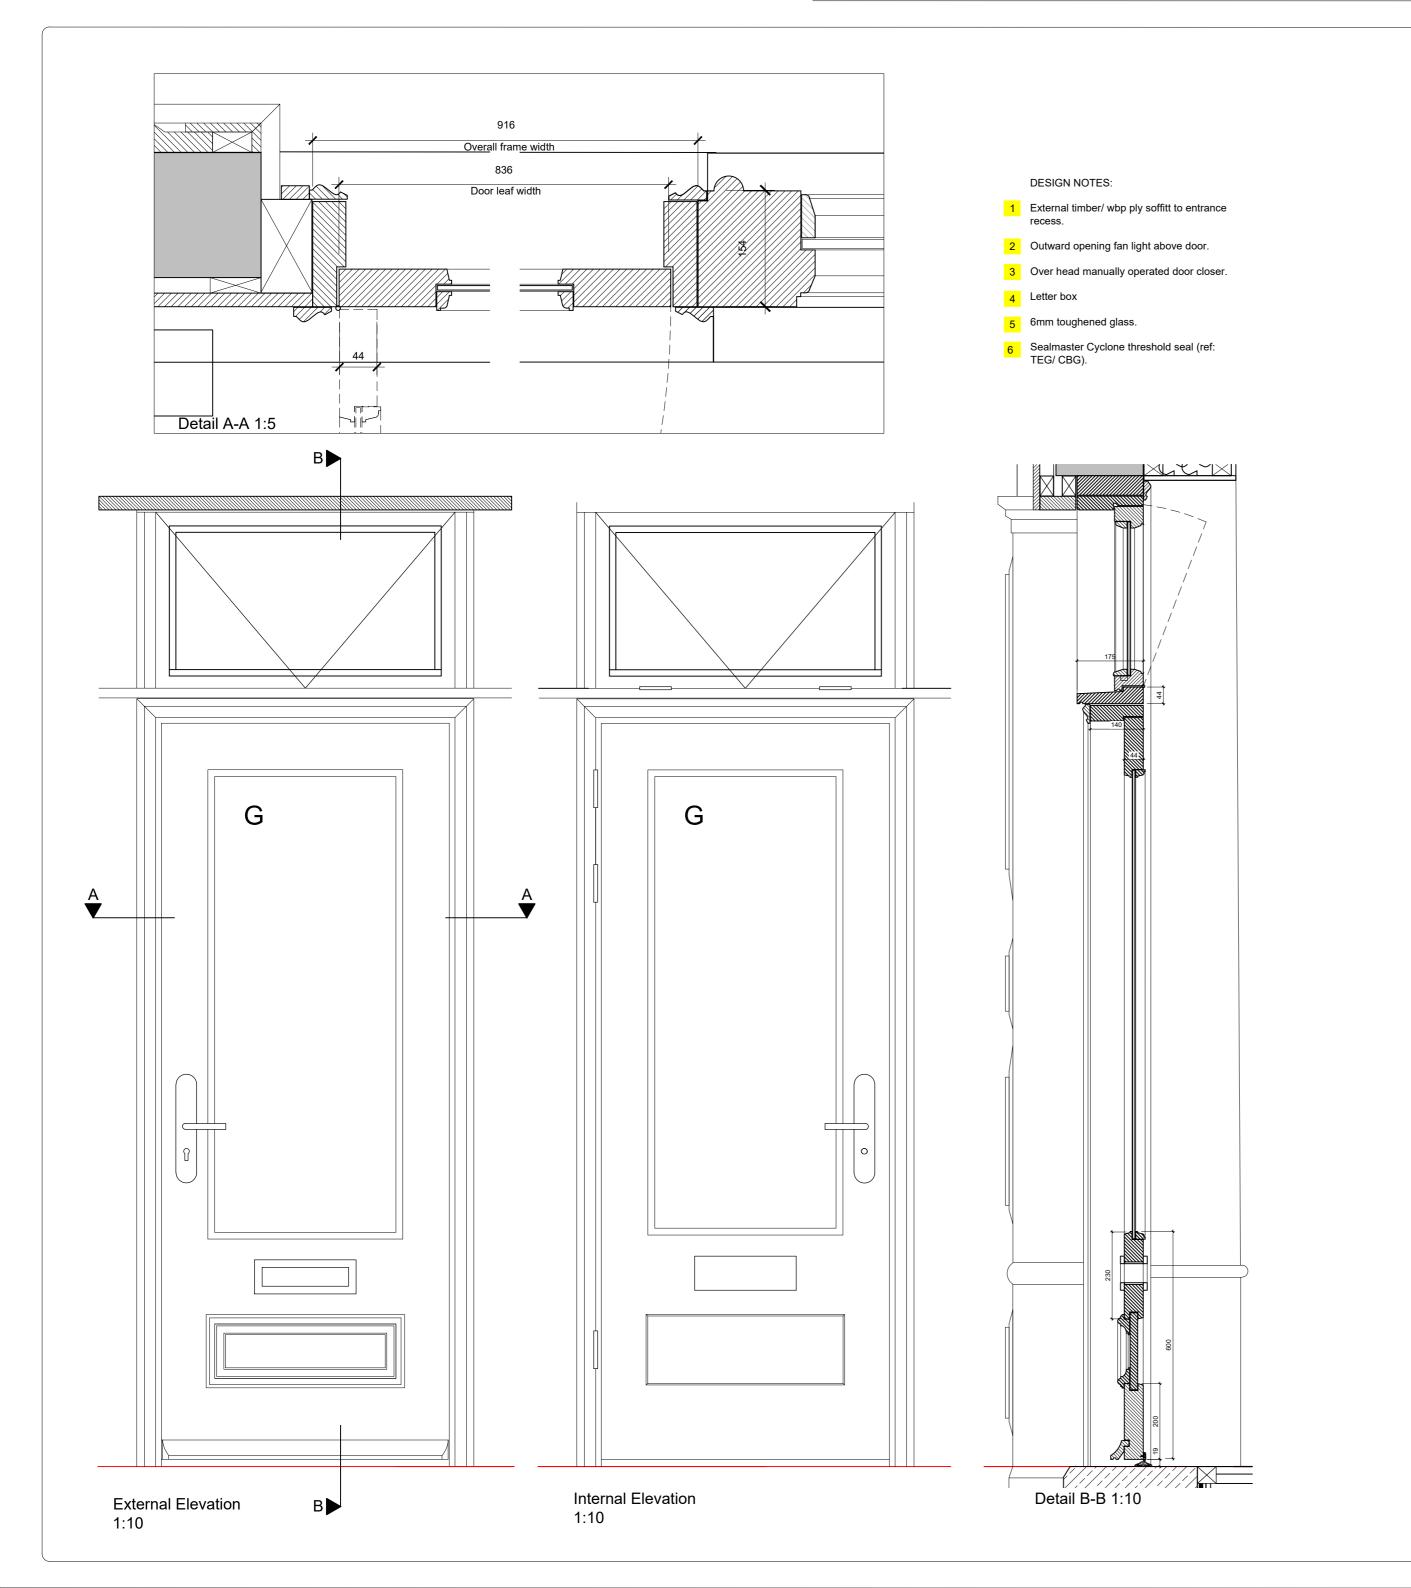

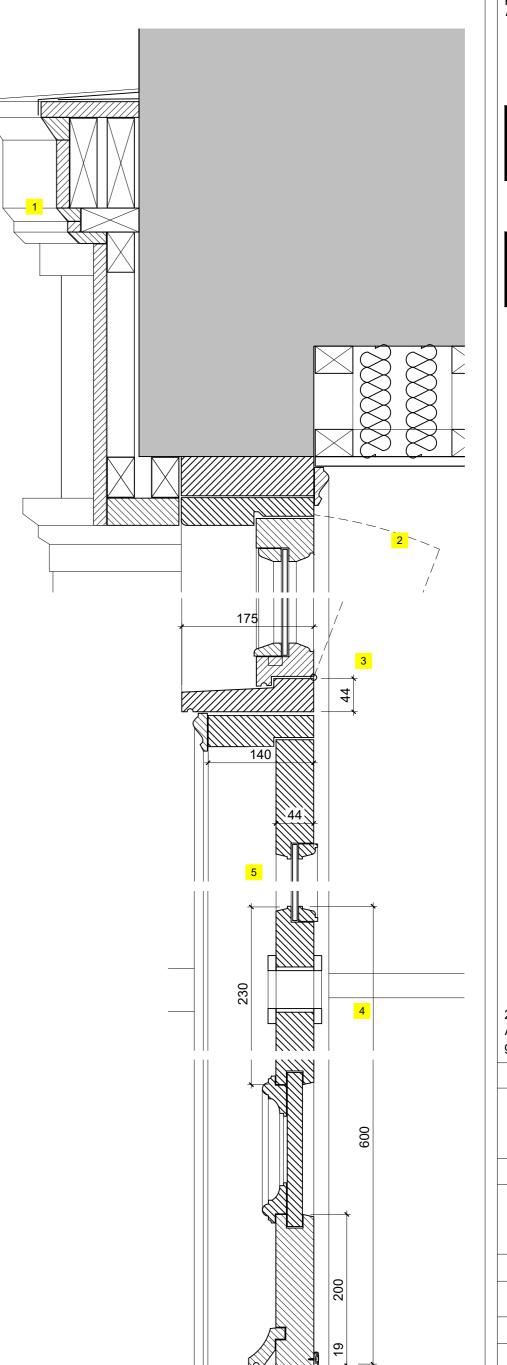

Detail B-B 1:5

THIS DRAWING IS PROTECTED BY COPYRIGHT AND MUST NOT BE COPIED OR REMOVED WITHOUT THE WRITTEN CONSENT OF ARCTIC ASSOCIATES LTD © NO DIMENSIONS ARE TO BE SCALED FROM THIS DRAWING. ALL DIMENSIONS AND SIZES TO BE CHECKED ON SITE.

Refer to the Specification of Works document for the description of re-pointing works to all elevations.

IRONMONGERY: Refer to Architectural Hardware Schedule by Monaghans. Schedule No. P115352

24.07.24 Rev A
Agreed extent of work following tender and
grant review CWE

Job

31 Queen Street Morley


Drawing title

Shop Front Door

Date	Scale@A2	Rev
May 2024	1: 50	Α
Drawing No.	Drawn by	Checked
4615-T-07	DDA	RCT



ARCTIC ASSOCIATES LTD
33 Queen Street
Morley
Leeds, LS27 8EE
T: 0113 253 7040
design@arctic-associates.co.uk
www.arctic-associates.co.uk

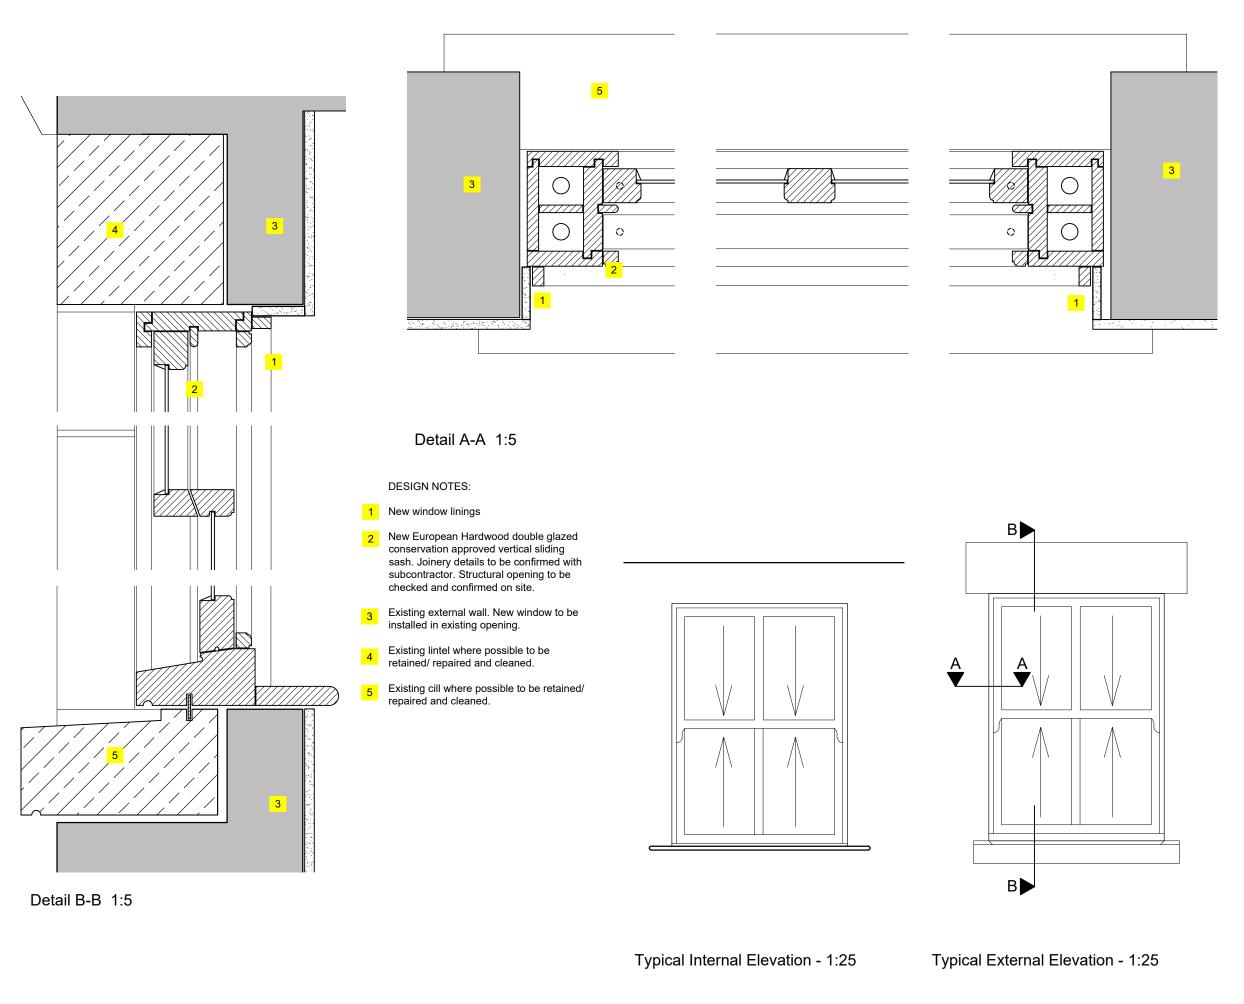

THIS DRAWING IS PROTECTED BY COPYRIGHT AND MUST NOT BE COPIED OR REMOVED WITHOUT THE WRITTEN CONSENT OF ARCTIC ASSOCIATES LTD © NO DIMENSIONS ARE TO BE SCALED FROM THIS DRAWING. ALL DIMENSIONS AND SIZES TO BE CHECKED ON SITE.

24.07.24 Rev A
Agreed extent of work following tender
and grant review CWE

Job

31 Queen Street Morley

Drawing Title

New Sash Window details W2 & W3

Date		Scale	@A3
May 2024		1:25 &	5
Drawing No.	Dra	wn by	Rev
4615-T-08	DDA	4	Α
	May 2024 Drawing No.	May 2024 Drawing No. Dra	May 2024 1:25 & Drawing No. Drawn by



ARCTIC ASSOCIATES LTD 33 Queen Street Morley Leeds, LS27 8EE T: 0113 253 7040 design@arctic-associates.co.uk Job No. 4615

Author: DDA

Site Address:

Drawing Title: Door Schedule Site Address: 31 Queen Street, Morley, LS27 8EE

Location	Door Number	New/ Existing	Type/Description	Door Leaf Size (H x W x D) mm	Frame Size (mm)	Architrave	Fire Rating	Decoration	Glazing	Ironmongery	Misc	Lintel
Ground Floor	D1	New	ENTRANCE DOOR: 44mm SW door with fully glazed main panel. Painted finish. 6mm Hardwood lippings to all edges. Openable top light above.	1981 x 762 x 44	44 x 140	50 x 19 Ogee profile	N/A	Door and architrave and all shop front joinery to receive 1no. primer coat, 1no. undercoat and a minimum of 2no. finishing coats. Finish: TBC Colour: TBC	8.3mm LandVac Heritage Glazing	Sealmaster Watershed threshold seal TES/CBS to suit door width. Threshold to be bedded in silicone and fixed to floor with screws/ plugs. Contact strip fixed to door with screws. Ironmongery to comply with AD Part M for entrance doors. See separate ironmongery schedule.	See separate ironmongery schedule.	Entrance door is a component of shop front element. Refer to architect's drawing 4615-T-06 & 07.

Location	Window Number	Existing / New	Description	Structural opening size WxH	Glazing	Ironmongery	Finish (Internal and External)	Miscellaneous	Cill	Lintel
Ground Floor Reception Shop Front Windows	W1	New	Shopfront. See detail drawings 4615_T_05 & 06	As Existing. (all dimensions to be checked on site before manufacturing)	8.3mm LandVac Heritage Glazing	See the schedule by Monaghan Hardware.	Shop front joinery to receive 1no. primer coat, 1no. undercoat and a minimum of 2no. finishing coats. Internal Colour: TBC Finish: Gloss External Colour: TBC Finish: TBC	Decoration includes window backs. Read in conjunction with drawing 4615_T_05, 06 & 08.	Existing Stone	Existing Stone
First Floor	W2	New	Sash Window	As Existing. (all dimensions to be checked on site before manufacturing)	New double-glazing with a U-value of 1.4 W/m2K or minimum WER Band B.	See the schedule by Monaghan Hardware.	Shop front joinery to receive 1no. primer coat, 1no. undercoat and a minimum of 2no. finishing coats. Internal Colour: TBC Finish: TBC External Colour: TBC Finish: TBC	Decoration includes window backs. Read in conjunction with drawing 4615_T_05, 06 & 08.	Existing Stone	Existing Stone
Second Floor	W3	New	Sash Window	As Existing. (all dimensions to be checked on site before manufacturing)	New double-glazing with a U-value of 1.4 W/m2K or minimum WER Band B.s	See the schedule by Monaghan Hardware.	Shop front joinery to receive 1no. primer coat, 1no. undercoat and a minimum of 2no. finishing coats. Internal Colour: TBC Finish: TBC External Colour: TBC Finish: TBC	Decoration includes window backs. Read in conjunction with drawing 4615_T_05, 06 & 08.	Existing Stone	Existing Stone